GENERAL DEMOLITION NOTES

GENERAL:

- FIELD VERIFY ALL EXISTING CONDITIONS AND NOTIFY ARCHITECT OF ANY DISCREPANCIES IN WRITING PRIOR TO ONSET OF DEMOLITION. DEMOLITION/RESTORATION ITEMS MAY NOT BE ALL INCLUSIVE. THE DEMOLITION CONTRACTOR IS TO REVIEW THE REQUIREMENTS OF NEW CONSTRUCTION AND IS TO COMPLETE ALL DEMOLITION/ RESTORATION, CUTTING, AND PATCHING NECESSARY TO ACHIEVE INTENDED NEW CONDITION AND
- SELECTIVE DEMOLITION IS NOT INDICATED IN AREAS WHERE IT MAY BE NECESSARY TO DEMOLISH ALL OR PART OF AN EXISTING BUILDING COMPONENT TO GAIN ACCESS TO AREAS FOR TIE-IN TO BUILDING SYSTEMS, OR WHICH MAY BE REQUIRED TO INSTALL NEW CONSTRUCTION INDICATED ON THE DRAWINGS DEMOLITION FOR THESE PURPOSES SHALL BE DONE AT NO ADDITIONAL COST TO THE OWNER, AND THE AREAS SHALL BE RETURNED TO THEIR ORIGINAL CONDITION PRIOR TO BEGINNING CONSTRUCTION
- DEMOLITION WORK SHALL BE EXECUTED IN CONFORMANCE WITH THE LOCAL BUILDING CODES.
- EXERCISE EXTREME CAUTION IN THIS DEMOLITION, COST OF REPAIR TO ANY ADJACENT CONDITIONS WHICH ARE DAMAGED AS A RESULT OF THIS DEMOLITION SHALL BE THE RESPONSIBILITY OF THE CONTRACTOR
- RELOCATION OF MATERIAL: RELOCATION OF ANY ITEMS INVOLVED IN THE PROJECT IS SUBJECT TO THE ABILITY, TO DO SO WITHOUT PERMANENTLY DAMAGING OR MARRING THE ITEMS TO BE RELOCATED. IF RELOCATION OF ANY ITEM IS NOT POSSIBLE AS PRESCRIBED HEREIN, NEW MATERIALS SHALL BE SUBSTITUTED TO MATCH EXISTING. SAFELY STORE MATERIAL TO BE REUSED UNTIL TIME OF INSTALLATION
- CERTAIN ITEMS ARE TO BE RETURNED TO THE BUILDING OWNER. COORDINATE WITH THE BUILDING OWNER WHICH ITEMS ARE TO BE
- RETURNED AND THE LOCATION SAID ITEMS ARE TO BE STORED.
 ALL MATERIALS TO BE DISPOSED OF ARE TO BE DISPOSED OF BY THE CONTRACTOR OFF THE PROJECT SITE IN ACCORDANCE WITH LOCAL RESTRICTIONS UNLESS NOTED OTHERWISE HEREIN.
- ALL AREAS SHALL BE KEPT IN A BROOM CLEAN CONDITION AT ALL

ARCHITECTURE:

ALL DOORS TO BE REMOVED ARE TO BE PUT IN STORAGE FOR FUTURE USE BY BUILDING OWNER, BUILDING OWNER IS TO DIRECT CONTRACTOR AS TO WHERE THESE ITEMS SHOULD BE STORED.

STRUCTURAL:

PROTECT ALL STRUCTURAL MEMBERS FROM DAMAGE.

FINISHES:

- REMOVE ALL EXISTING WALL COVERING ON PARTITIONS DESIGNATED TO REMAIN AND PATCH AND REPAIR ALL WALL SURFACES UNLESS NOTED OTHERWISE ON PLANS, SCHEDULES,
- REMOVE ALL EXISTING FLOOR FINISHES AND PREPARE SLAB TO RECEIVE NEW FLOOR FINISHES UNLESS NOTED OTHERWISE ON PLANS, SCHEDULES, OR NOTES.
- PATCH AND REPAIR ALL AREAS WHERE A DEMOLISHED WALL INTERSECTS A REMAINING WALL, EITHER FINISH EXISTING WALL TO MATCH ADJACENT SURFACES, OR PREPARE WALL TO RECEIVE NEW FINISHES, AS DIRECTED BY FINISH PLANS, SCHEDULES, AND

ADOPTED CODES

THIS STRUCTURE HAS BEEN DESIGNED TO MEET OR EXCEED REQUIREMENTS OF THE FOLLOWING CODE EDITIONS:

- FLORIDA BUILDING CODE 7TH EDITION, 2020
- FLORIDA BUILDING CODE RESIDENTIAL 7TH EDITION, 2020
- FLORIDA BUILDING CODE EXISTING BUILDING 7TH EDITION, 2020
- FLORIDA BUILDING CODE ACCESSIBILITY 7TH EDITION, 2020
- FLORIDA BUILDING CODE MECHANICAL 7TH EDITION, 2020
- FLORIDA BUILDING CODE PLUMBING 7TH EDITION, 2020
- NATIONAL ELECTRICAL CODE (NEC) 2017
- FLORIDA FIRE PREVENTION CODE 7TH EDITION, 2020

SCOPE OF WORK

DRAWINGS FOR AN EXISTING GAZEBO ENCLOSURE. ALL WORK TO COMPLY WITH OWNER REQUIREMENTS AND FLORIDA BUILDING CODE, 2020

CONSTRUCTION TYPE V-B RESIDENTIAL

> NUMBER OF STORIES- ONE **BUILDING HEIGHT-**20' MAX.

STRUCTURAL DESIGN CRITERIA

EXPOSURE CATEGORY: В BASIC WIND SPEED: 140 INTERNAL PRESSURE COEFFICIENTS: WIND INPORTANCE FACTOR: BUILDING, ENCLOSED - +/- 0.18 ROOF DESIGN WIND PRESSURE: 30 P.S.F.

ROOF LOADS:

FBC, SECTION 1604.6 TOP CHORD LIVE LOAD: 20.0 TOP CHORD DEAD LIVE LOAD: 7.0/15.0 BOTTOM CHORD DEAD LIVE LOAD: 10.0 ROOF LIVE LOAD EQUALS WIND LOADS, FBC 1604.6 ROOF DEAD LOAD EQUALS WEIGHTS OF MATERIALS AND CONSTRUCTION.FBC TABLE A1 SECT. 4101.

FLOOR

LIVE LOAD- 40 P.S.F. DEAD LOAD- 20 P.S.F. SOIL BEARING PRESSURE = 2,000. P.S.F. MIN.

ROOF & WIND LOADS

ROOF LIVE LOAD- 30 P.S.F. SHINGLE: 20 P.S.F. ROOF DEAD LOAD-TILE: 40 P.S.F.

FLOOR LOADS:

FLOOR LIVE LOAD EQUALS LOAD PRODUCED BY RESIDENTIAL OCCUPANCY, FBC TABLE 1604.1 FLOOR DEAD LOAD EQUALS WEIGHTS OF MATERIALS AND CONSTRUCTION, FBC TABLE A1 SECT. A101. WINDOW DESIGN WIND PRESSURE:

A. POSITIVE PRESSURE OF 22 P.S.F.

B. NEGATIVE PRESSURE OF 30 P.S.F.

DOOR DESIGN WIND PRESSURE:

SLIDING GLASS DOORS: ALL SIZES

A. POSITIVE PRESSURE OF 21 P.S.F.

B. NEGATIVE PRESSURE OF 28 P.S.F.

ENTRY DOORS: ALL CONFIGURATIONS

A. POSITIVE PRESSURE OF 20 P.S.F.

B. NEGATIVE PRESSURE OF 25 P.S.F.

GARAGE DOORS: ALL GARAGE DOORS


A. POSITIVE PRESSURE OF 20 P.S.F. B. NEGATIVE PRESSURE OF 24.5 P.S.F.

WIND IMPORTANCE FACTOR- 1.00 BASIC WIND SPEED- 140 M P H WIND IMPORTANCE FACTOR- 1.00 WIND EXPOSURE- B

APPLICABLE INTERNAL PRESSURE COEFFICIENT- + INCREASE + .18

NEGATIVE INCREASE .4 DESIGN PARAMETERS

2- STORY MAX. HGT. - 35'-0" = 26.8 P.S.F. @ 140 M.P.H.

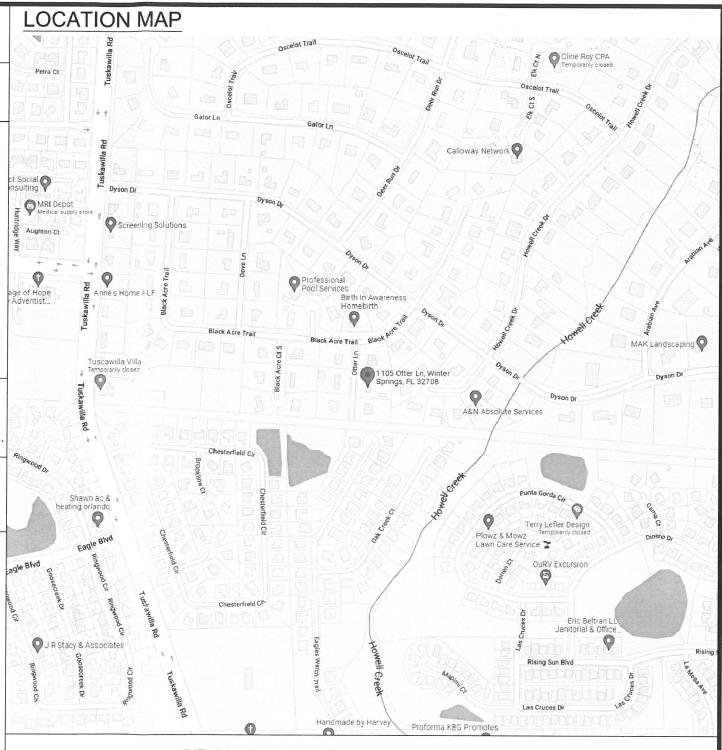

DRAWING INDEX

SHEET NO. A-5

SHEET NO. C-S COVER SHEET SHEET NO. A-0 SITE PLAN SHEET NO. A-1 **EXISTING FLOOR PLAN & ELEVATIONS** SHEET NO. A-2 PROPOSED FLOOR PLAN SHEET NO. A-3 PROPOSED ELEVATIONS & SECTION SHEET NO. A-4 STRUCTURAL DETAILS

ELECTRICAL & MECHANICAL LAYOUT PLAN

REVISIONS

ACROSS STATE SERVICES, L.L.C.

ENGINEERING * INSPECTION

1225 BENNETT DR., SUITE 129 LONGWOOD, FL. 32750 PHONE: (407) 221-0619

DISCREPANCIES IN DRAWINGS SITE, ALL DIAGRAMS AND DIMENSIONS SHOWN ON DRAWINGS AND SHALL IMMEDIATELY NOTIFY THE ENGINEER OF ANY DISCREPANCIES WHICH MA APPEAR. THE CONTRACTOR SHALL NOT PROCEED WITH THE WORK AFFECTE THEREBY UNTIL THE ENGINEER HAS CORRECTED THE DISCREPANCY

GOODMAN JAMES (

ಹ


KRISTAL

HIS STRUCTURE HAS BEEN DESIGNED TO THIS STRUCTURE HAS BEEN DESIGNED TO WITHSTAND THE FORCES GENERATED BY 14 M.P.H. WINDS PLUS THREE SECOND GUST FACTOR IN COMPLIANCE WITH SECTION 1600 OF 2020 FLORIDA BUILDING CODE RESIDENTIAL REVISIONS AND SUPPLEMENTS

WILLIAM SANCHEZ ADORNO, PE P.E. # 68868

DRAWN BY: RL	DESIGN BY:
DATE: 09/22/22	CHECKED BY:
лов.#: 11-20220830-1	SCALE: AS NOTED

G-1

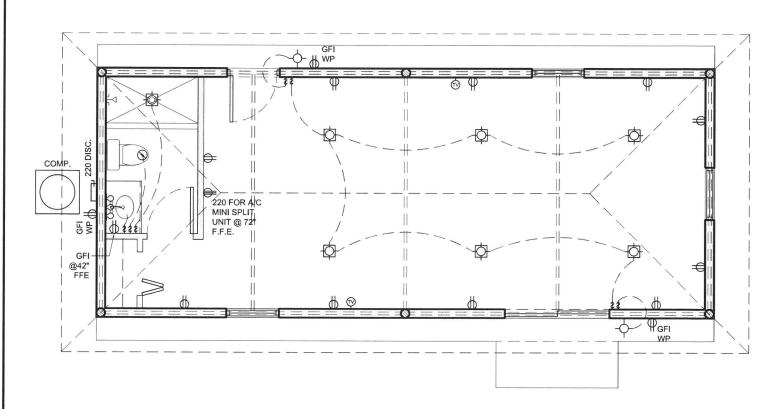





ELECTRICAL LAYOUT PLAN


SCALE: 3/16"=1'-0"

GENERAL ELECTRICAL NOTES: CONNECT NEW ELECTRICAL FIXTURES TO EXISTING ELECTRICAL PANEL.

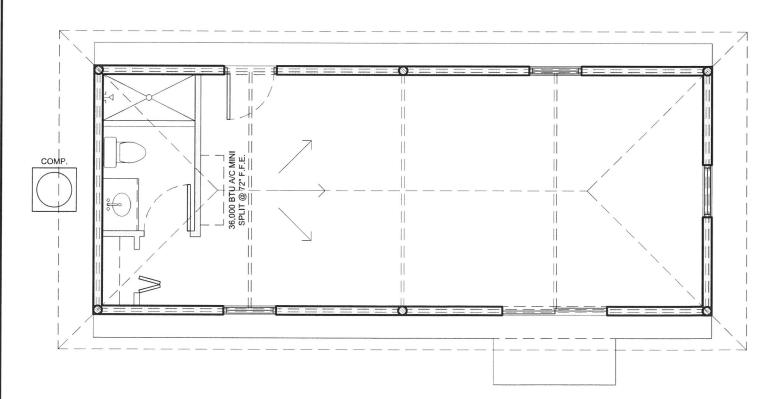

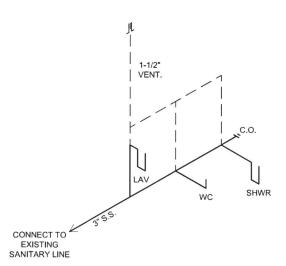



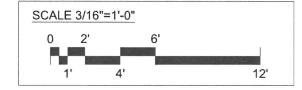

	TOAL ELUCIAD
SYMBOL	DESCRIPTION CEILING MOUNTED LIGHT
	CEILING MOUNTED LIGHT
\$	RECESSED LIGHT
-ф-	WALL MOUNTED LIGHT
- \$ -	PENDANTS LIGHT
<u></u> ဝဝ္ပိဝ	CHANDELIER
	CEILING FAN
000	WALL MOUNTED MULTI-LIGHT FIXTURE
$\nabla\nabla\nabla$	TRACK LIGHT
	FLUORESCENT LIGHT
\$	SPOT LIGHT
0	EXHAUST FAN
00	FAN / LIGHT COMBINATION
댓	DOORBELL CHIME
•	PUSH BOTTOM
\$	WALL SWITCH
\$ 3W	3 WAY SWITCH
\$ □	DIMMER SWITCH
Ф	DUPLEX RECEPTACLE
•	220 V RECEPTACLE
Ф	1/2 HOT, 1/2 SWITCHED RECEPTACLE
₩Р	WEATHER PROOF RECEPTACLE
Ф	FLOOR RECEPTACLE
∯gFI	GROUND FAULT INTERRUPT
Ф	PRE-WIRED FOR CEILING FAN
Φ	PRE-WIRED GARAGE DOOR OPENER
®	CABLE JACK
∇	TELEPHONE JACK
W	METER
	ELECTRICAL PANEL
	DISCONNECT SWITCH
SD	SMOKE DETECTOR & CARBON MONOXIDE COMBO
9	GARBAGE DISPOSAL MOTOR

ELECTRICAL LEGEND

REVISIONS	BY



ACROSS STATE SERVICES, L.L.C.

ENGINEERING * INSPECTION 1225 BENNETT DR., SUITE 129 LONGWOOD, FL. 32750 PHONE: (407) 221-0619 EMAIL: acrossstateservices@gmail.com

DISCREPANCIES IN DRAWINGS THE CONTRACTOR SHALL CHECK AT THE SITE, ALL DIAGRAMS AND DIMENSIONS SHOWN ON DRAWINGS AND SHALL IMMEDIATELY NOTIFY THE ENGINEER OF ANY DISCREPANCIES WHICH MAY APPEAR. THE CONTRACTOR SHALL NOT PROCEED WITH THE WORK AFFECTED THEREBY UNTIL THE ENGINEER HAS CORRECTED THE DISCREPANCY.

KRISTAL & JAMES GOODMAN GAZEBO ENCLOSURE

THIS STRUCTURE HAS BEEN DESIGNED TO WITHSTAND THE FORCES GENERATED BY 140 M.P.H. WINDS PLUS THREE SECOND GUST FACTOR IN COMPLIANCE WITH SECTION 1600 OF 2020 FLORIDA BUILDING CODE RESIDENTIAL, REVISIONS AND SUPPLEMENTS.


WILLIAM SANCHEZ ADORNO, PE P.E. # 68868


DRAWN BY: RL	DESIGN BY:
DATE: 09/22/22	CHECKED BY:
^{30В.#:} 11-20220830-1	SCALE: AS NOTED

A-5



2 MECHANICAL LAYOUT PLAN
SCALE: 3/16"=1'-0"

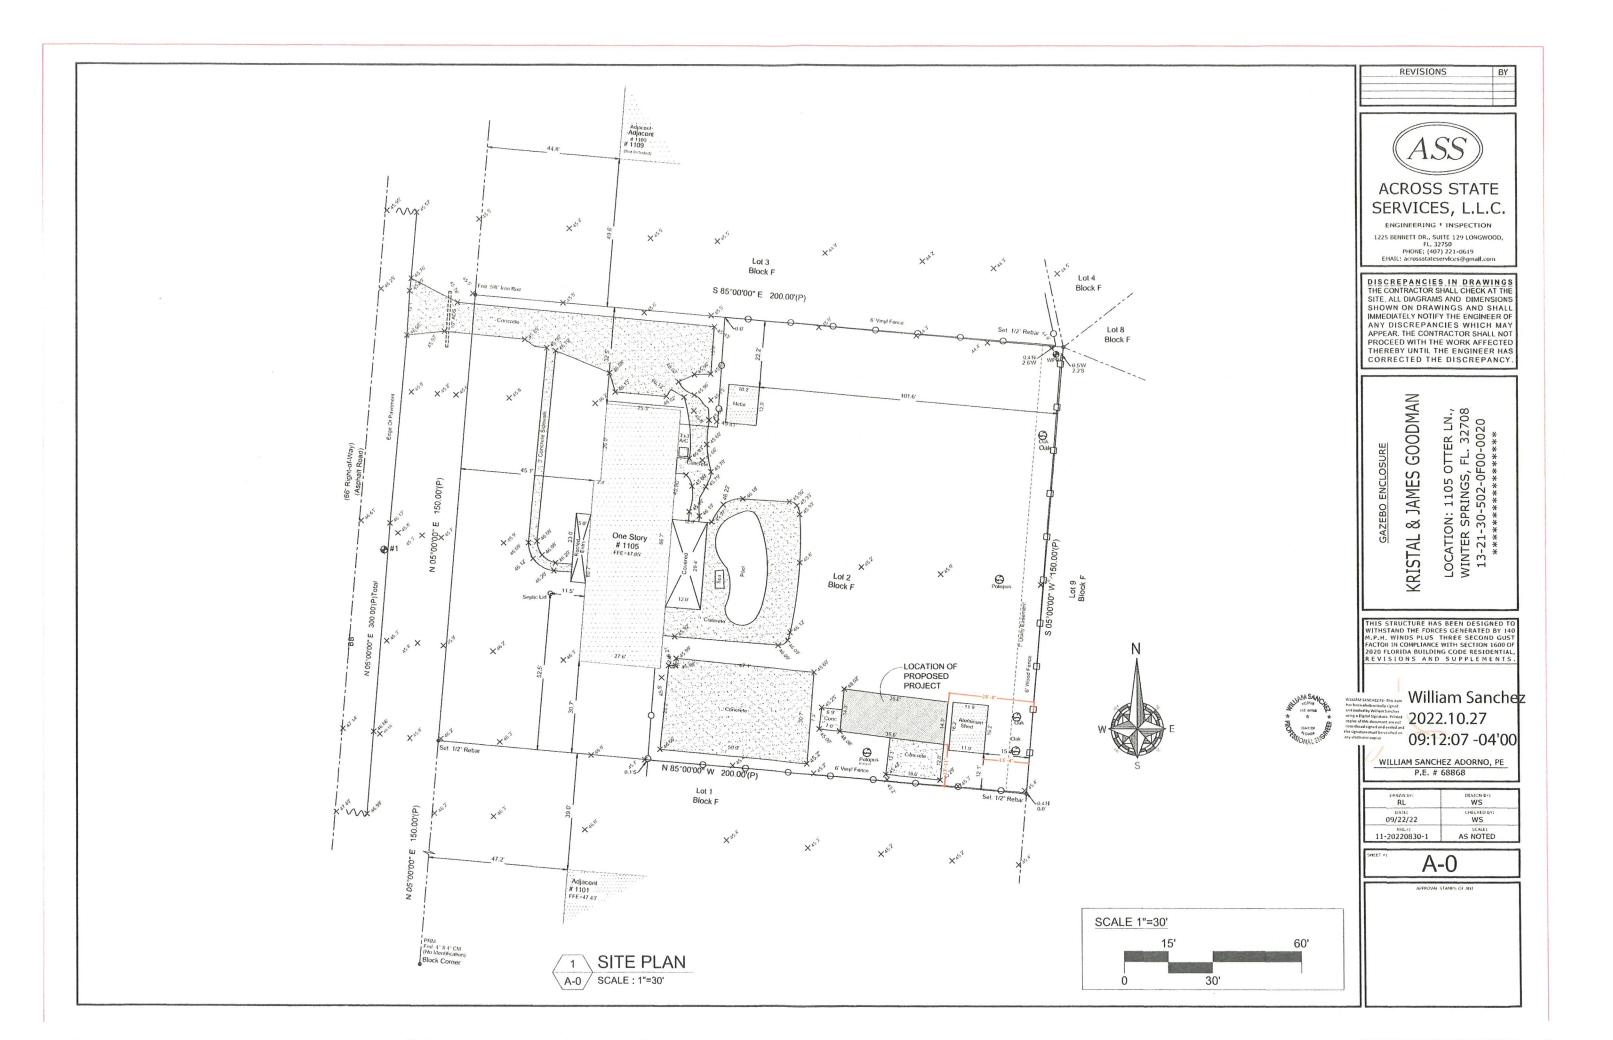

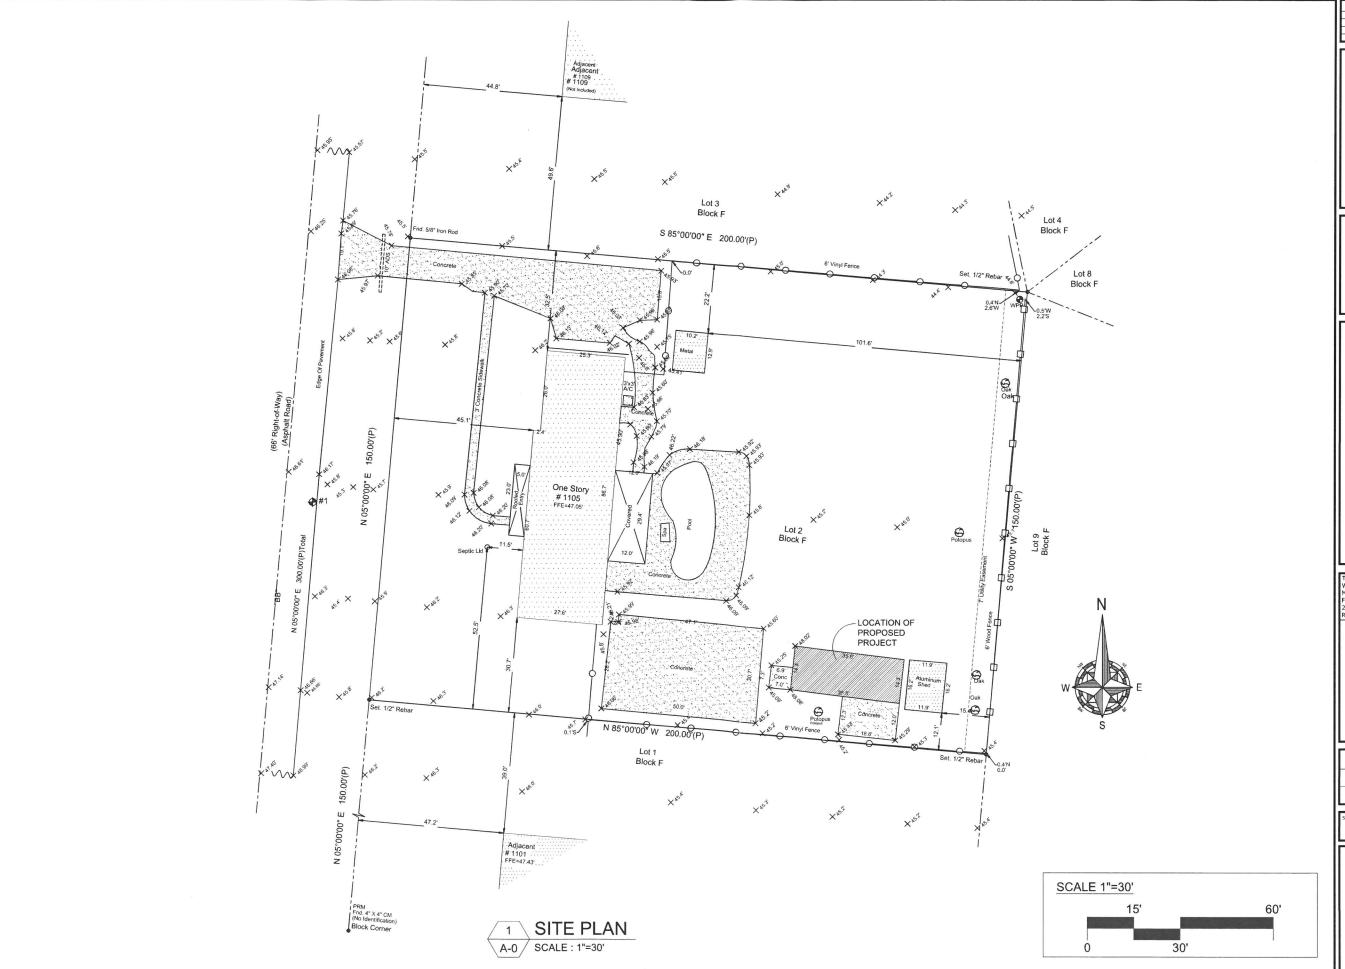

REVISIONS



ENGINEERING * INSPECTION

1225 BENNETT DR., SUITE 129 LONGWOOD, FL. 32750 PHONE: (407) 221-0619 EMAIL: acrossstateservices@gmail.com

DISCREPANCIES IN DRAWINGS THE CONTRACTOR SHALL CHECK AT THE SITE, ALL DIAGRAMS AND DIMENSIONS SITE, ALL DIAGRAMS AND DIMENSIONS SHOWN ON DRAWINGS AND SHALL IMMEDIATELY NOTIFY THE ENGINEER OF ANY DISCREPANCIES WHICH MAY APPEAR. THE CONTRACTOR SHALL NOT PROCEED WITH THE WORK AFFECTED THEREBY UNTIL THE ENGINEER HAS CORRECTED THE DISCREPANCY.


KRISTAL & JAMES GOODMAN GAZEBO ENCLOSURE


THIS STRUCTURE HAS BEEN DESIGNED TO WITHSTAND THE FORCES GENERATED BY 140 M.P.H. WINDS PLUS THREE SECOND GUST FACTOR IN COMPLIANCE WITH SECTION 1600 OF 2020 FLORIDA BUILDING CODE RESIDENTIAL, REVISIONS AND SUPPLEMENTS.


WILLIAM SANCHEZ ADORNO, PE P.E. # 68868

DRAWN BY: RL	DESIGN BY:
DATE: 09/22/22	CHECKED BY:
11-20220830-1	SCALE: AS NOTED

A-0

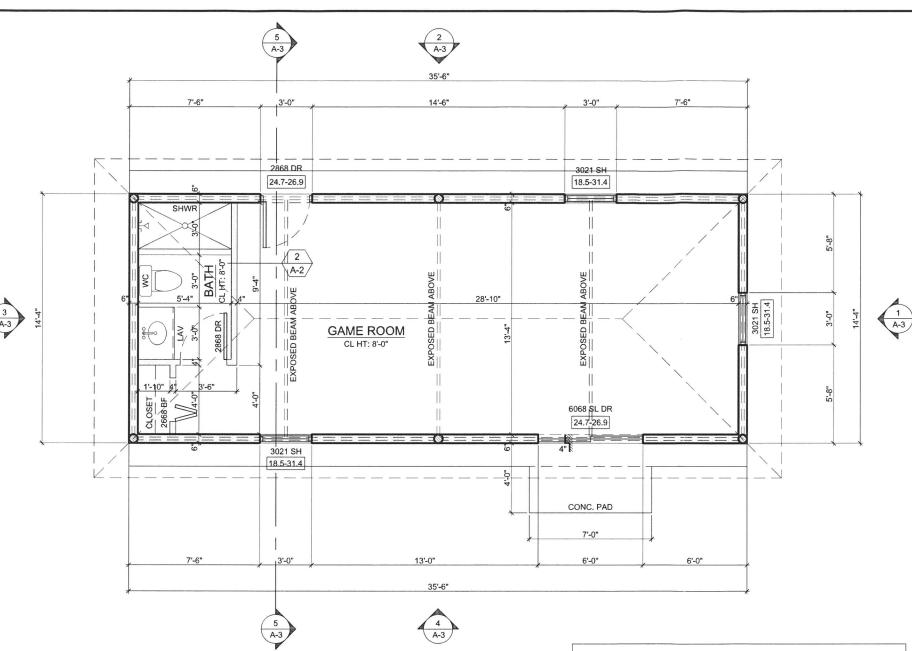

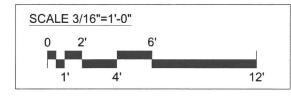

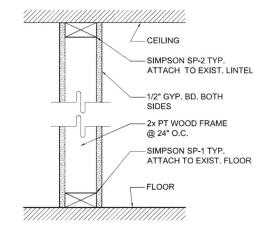

INTERIOR WALL DETAIL NOT TO SCALE 4-1/2" THICKNESS A-2 NON RATED PARTITION

NOTES:

508 SQ FT 508 SQ FT

- 1. ALL TUB & SHOWER UNITS WILL HAVE ANTI-SCALDING DEVICES INSTALLED.
 2. ALL DOORS TO BE 6'-8" TALL U.N.O. OR PER BUILDER / CLIENT.
- 3. MULTIPLE 2x4 STUDS NAILED TOGETHER W/ (1) 10d NAILS @ 8" O.C. EA PLY STAGGERED TYP.

ROOM FINISH SCHEDULE

	WINDOW	SCHED	ULE
MARK	SIZE	QT.	COMMENTS
3021 SH	3'-0" x 2'-1"	3	SINGLE HUNG

AREAS SCHEDULE

GAME ROOM / BATH

TOTAL AREA

	DC	OOR SCHE	DULE	=
SIZE	THKNS	MAT'L.	FRAME	COMMENTS
6'-0"x6'-8"	1 3/4"	ALUMINUM / GLASS	ALUM	SLIDING DOOR
2'-8"x6'-8"	1 3/4"	ALUMINUM / GLASS	ALUM	EXTERIOR DOOR
2'-8"x6'-8"	1 3/8"	HOLLOW CORE WOOD	WD	INTERIOR DOOR
2'-6"x6'-8"		WOOD	-	BI-FOULD DOOR
	6'-0"x6'-8" 2'-8"x6'-8" 2'-8"x6'-8"	SIZE THKNS 6'-0"x6'-8" 1 3/4" 2'-8"x6'-8" 1 3/4" 2'-8"x6'-8" 1 3/8"	SIZE THKNS MAT'L. 6'-0"x6'-8" 1 3/4" ALUMINUM / GLASS 2'-8"x6'-8" 1 3/4" ALUMINUM / GLASS 2'-8"x6'-8" 1 3/8" HOLLOW CORE WOOD	6'-0"x6'-8" 1 3/4" ALUMINUM / GLASS ALUM 2'-8"x6'-8" 1 3/4" ALUMINUM / GLASS ALUM 2'-8"x6'-8" 1 3/8" HOLLOW CORE WOOD WD

	-										
ROOM NAME		OC NIS		1	VAL BAS			VAL		ILII	
	CERAMIC TILE	POLISH CEMENT	CARPET	4" HIGH BASE (BY OWNER)			GYP. BD EGGSHELL ENAMEL PAINT		GYP. BD EGGSHELL ENAMEL PAINT		
GAME ROOM	X			X			X		X		
BATHROOMS	X			X			X		X		
	-			-		-			 		

REVISIONS



SERVICES, L.L.C. ENGINEERING * INSPECTION

1225 BENNETT DR., SUITE 129 LONGWOOD, FL. 32750 PHONE: (407) 221-0619 EMAIL: acrossstateservices@gmail.com

DISCREPANCIES IN DRAWINGS
THE CONTRACTOR SHALL CHECK AT THE SITE, ALL DIAGRAMS AND DIMENSIONS SHOWN ON DRAWINGS AND SHALL IMMEDIATELY NOTIFY THE ENGINEER OF ANY DISCREPANCIES WHICH MAY APPEAR. THE CONTRACTOR SHALL NOT PROCEED WITH THE WORK AFFECTED THEREBY UNTIL THE ENGINEER HAS CORRECTED THE DISCREPANCY.

GAZEBO ENCLOSURE

& JAMES GOODMAN KRISTAL 8

HIS STRUCTURE HAS BEEN DESIGNED MITHSTAND THE FORCES GENERATED BY 145 M.P.H. WINDS PLUS THREE SECOND GUS FACTOR IN COMPLIANCE WITH SECTION 1600 O REVISIONS AND SUPPLEMENTS

WILLIAM SANCHEZ ADORNO, PE P.E. # 68868

DRAWN BY: RL	DESIGN BY:
DATE: 09/22/22	CHECKED BY:
108.#: 11-20220830-1	SCALE: AS NOTED

A-2


PROPOSED FLOOR PLAN

SCALE: 3/16"=1'-0"

WOOD NOTES:

- ALL WOOD FRAMING SHALL BE DESIGNED, DETAILED AND FABRICATED IN
 ACCORDANCE WITH THE PROCEDURES AND REQUIREMENTS OUTLINED IN THE LATEST EDITION OF THE NATIONAL DESIGN SPECIFICATIONS FOR WOOD CONSTRUCTION.
- 2. FOR STRUCTURAL LUMBER, PROVIDE THE FOLLOWING GRADE AND SPECIES (EQUIVALENT OR BETTER) U.O.N.: SOUTHERN PINE OR SPRUCE PINE FIR SURFACES DRY USED AT 19% MAX. M.C. GRADE NO. 2.
- 3. ALL WOOD FRAMING IN DIRECT CONTACT WITH EARTH OR CONCRETE TO BE PRESSURE TREATED. THE USE OF METAL SEAT PLATES IN LIEU OF PRESSURE TREATED WOOD IS ACCEPTABLE.
- PROVIDE GALVANIZED METAL HANGERS AND FRAMING ANCHORS OF THE SIZE AND TYPE AS SHOWN IN THESE DOCUMENTS, CONNECT AS PER MANUFACTURER RECOMMENDATIONS. (SIMPSON STRONG TIE OR EQUIVALENT)
- 5. PROVIDE FRAMING MEMBERS OF SIZES AND OF SPACING SHOWN, OR IF NOT SHOWN, COMPLY WITH THE RECOMMENDATIONS OF THE FLORIDA BUILDING CODE, LATEST **FDITION**
- DO NOT SPLICE STRUCTURAL MEMBERS BETWEEN SUPPORTS.
- PROVIDE ANCHORAGE AND NAILING FOR MEMBERS AND SHEATHING AS SHOWN IN THE DWG'S AND TO COMPLY WITH THE FLORIDA BUILDING CODE, LATEST EDITION.

 8. ROOF FRAMING SHEATHING: 7/16" INCH THICK CDX, RATED "EXP. 1".

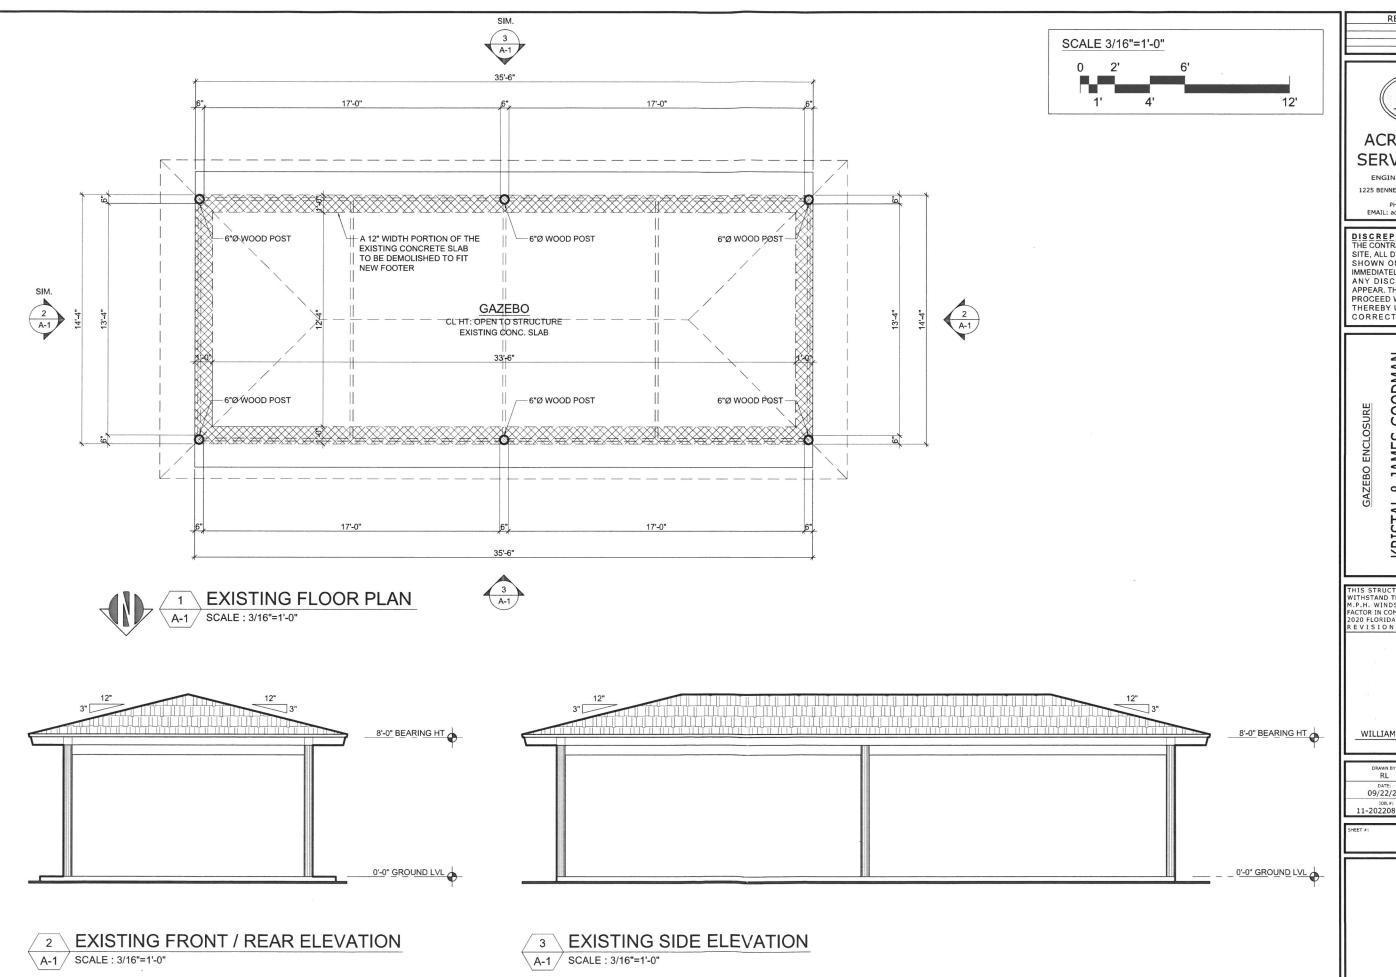

REVISIONS

ACROSS STATE SERVICES, L.L.C.

ENGINEERING * INSPECTION

1225 BENNETT DR., SUITE 129 LONGWOOD, FL. 32750 PHONE: (407) 221-0619 EMAIL: acrossstateservices@gmail.com

DISCREPANCIES IN DRAWINGS
THE CONTRACTOR SHALL CHECK AT THE
SITE, ALL DIAGRAMS AND DIMENSIONS SHOWN ON DRAWINGS AND SHALL IMMEDIATELY NOTIFY THE ENGINEER OF ANY DISCREPANCIES WHICH MAY APPEAR. THE CONTRACTOR SHALL NOT PROCEED WITH THE WORK AFFECTED THEREBY UNTIL THE ENGINEER HAS CORRECTED THE DISCREPANCY.

KRISTAL & JAMES GOODMAN

THIS STRUCTURE HAS BEEN DESIGNED TO WITHSTAND THE FORCES GENERATED BY 140 M.P.H. WINDS PLUS THREE SECOND GUST FACTOR IN COMPLIANCE WITH SECTION 1600 OF 2020 FLORIDA BULLDING CODE RESIDENTIAL, REVISIONS AND SUPPLEMENTS.

WILLIAM SANCHEZ ADORNO, PE P.E. # 68868

RL DRAWN BY:	DESIGN BY:
DATE: 09/22/22	CHECKED BY:
JOB.#: 11-20220830-1	SCALE: AS NOTED

A-1

Boundary Survey

